

Thoughts on new build.....a house




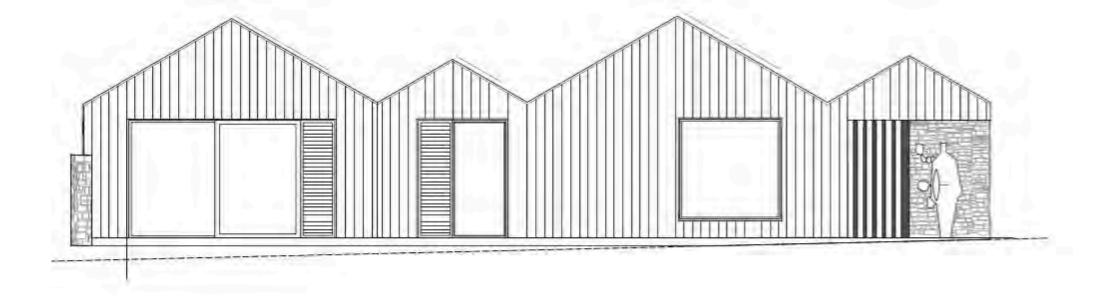


FRONT ELEVATION 1:

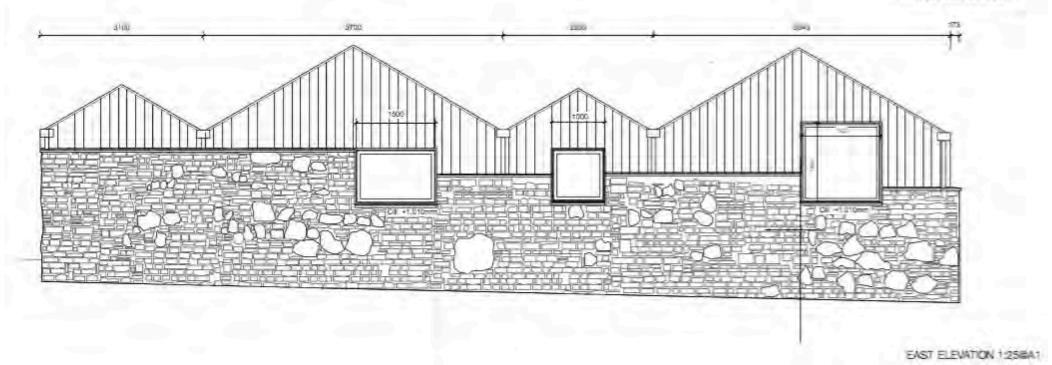



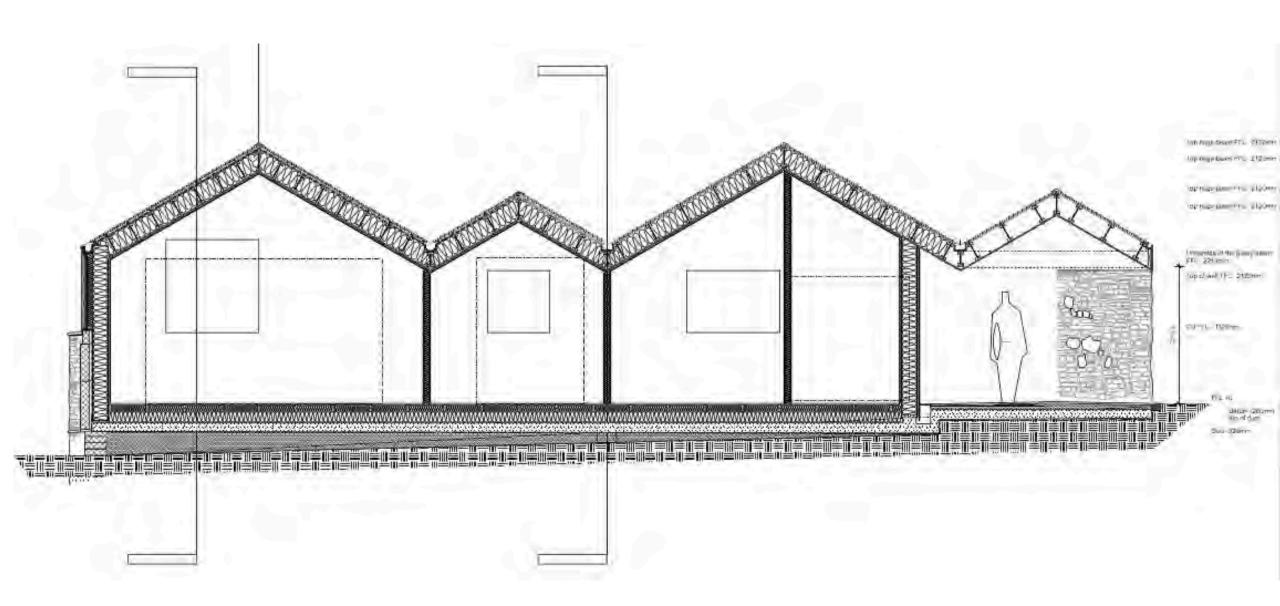


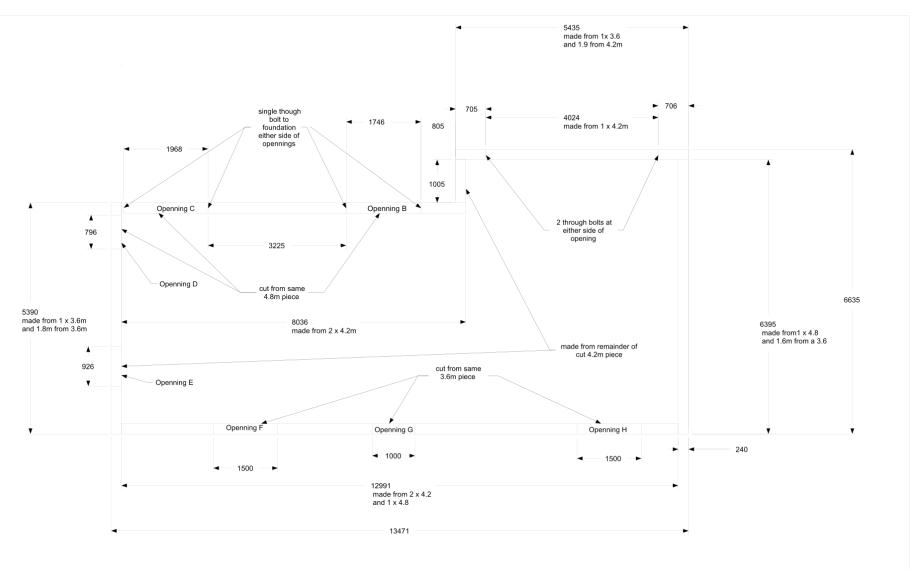



NOTES:


1)Apply compaband to underside of soleplate all round
2)Through bolts into foundation at 2m intervals except where marked
3) Sole plate cut list


| COPYRIGHTNEUTRONIUM LTD. 2014 | NEUTRONIUM LTD | | | sole plate layout | | Doc.Nr 001 | | | |
|--|-------------------------|---------------|--|----------------------|-------------------|------------------|------|------|--|
| PERMISSION OF NEUTRONIUM LTD IS PROHIBITED. | | | | | | Sheet 1 of 10 | Rev. | 1 | |
| THE INFORMATION CONTAINED IN THIS DRAWING IS THE SOLE PROPERTY OFNEUTRONIUM LTD ANY REPRODUCTION IN PART OR AS A WHOLE WITHOUT THE WRITTEN | | Scale 1:40 | | | Drawn R.LUXTON | Checked | Date | date | |
| | 3rd Angle Projection | A2 | | | | | | | |
| | | | | | | | | | |

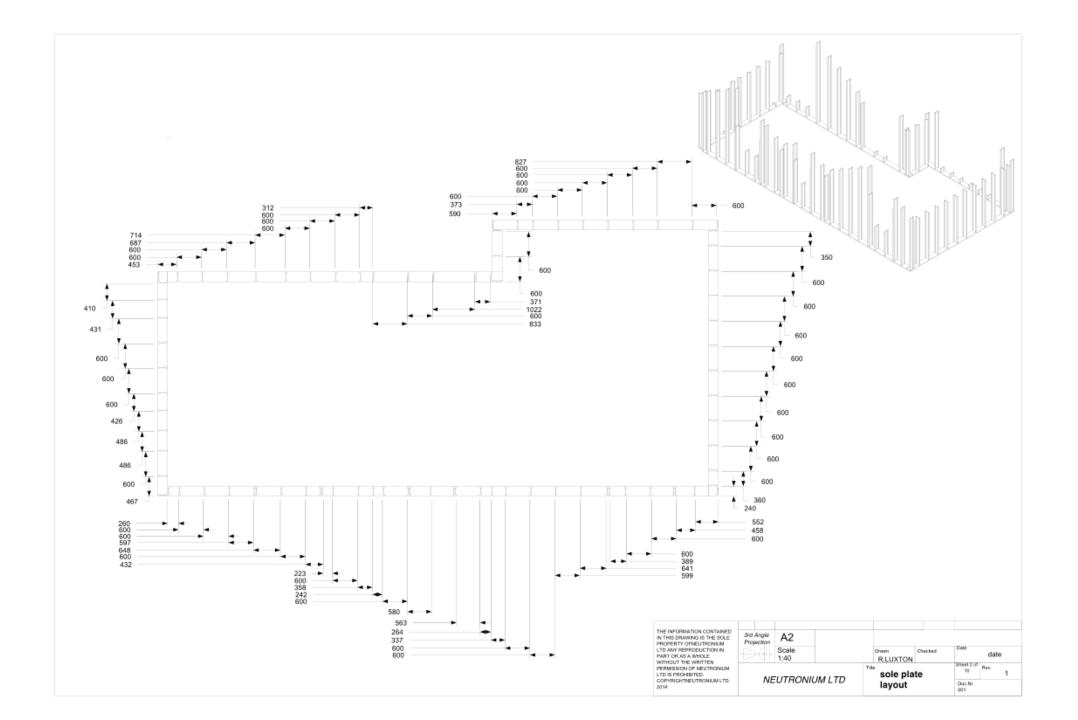


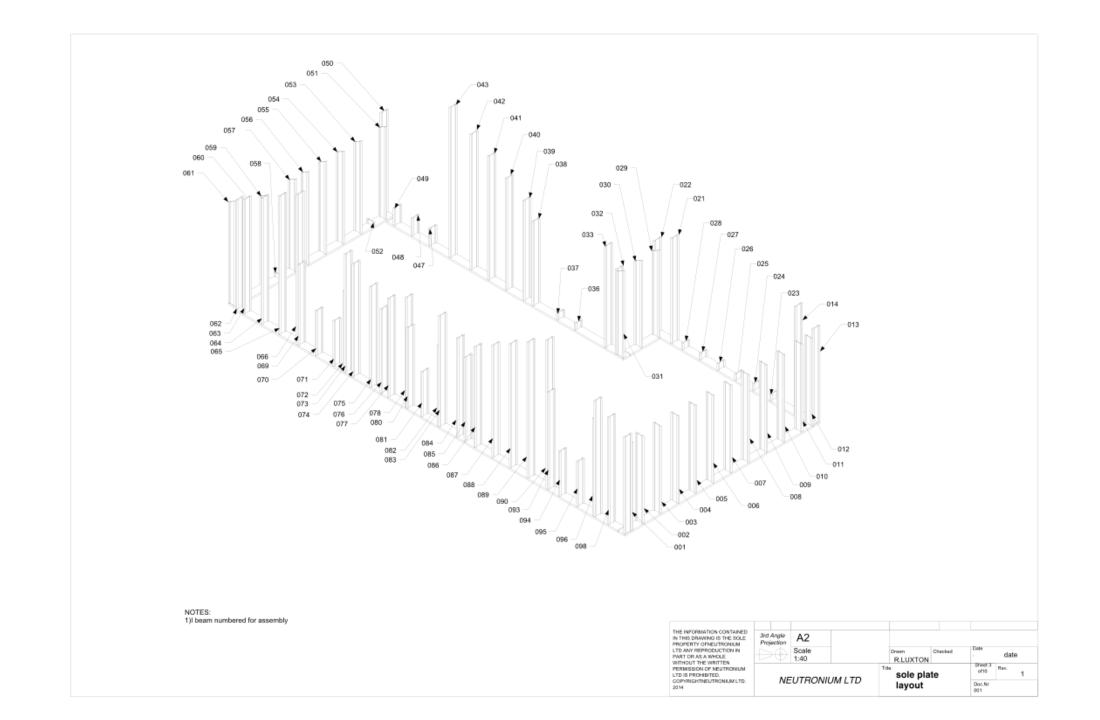

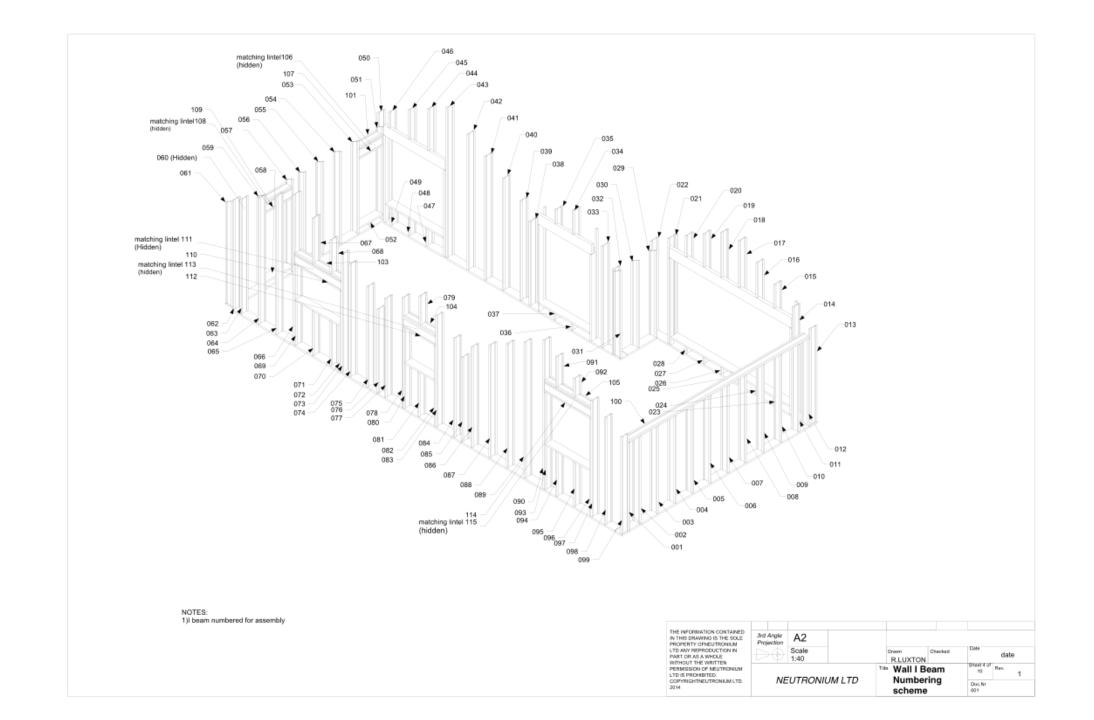


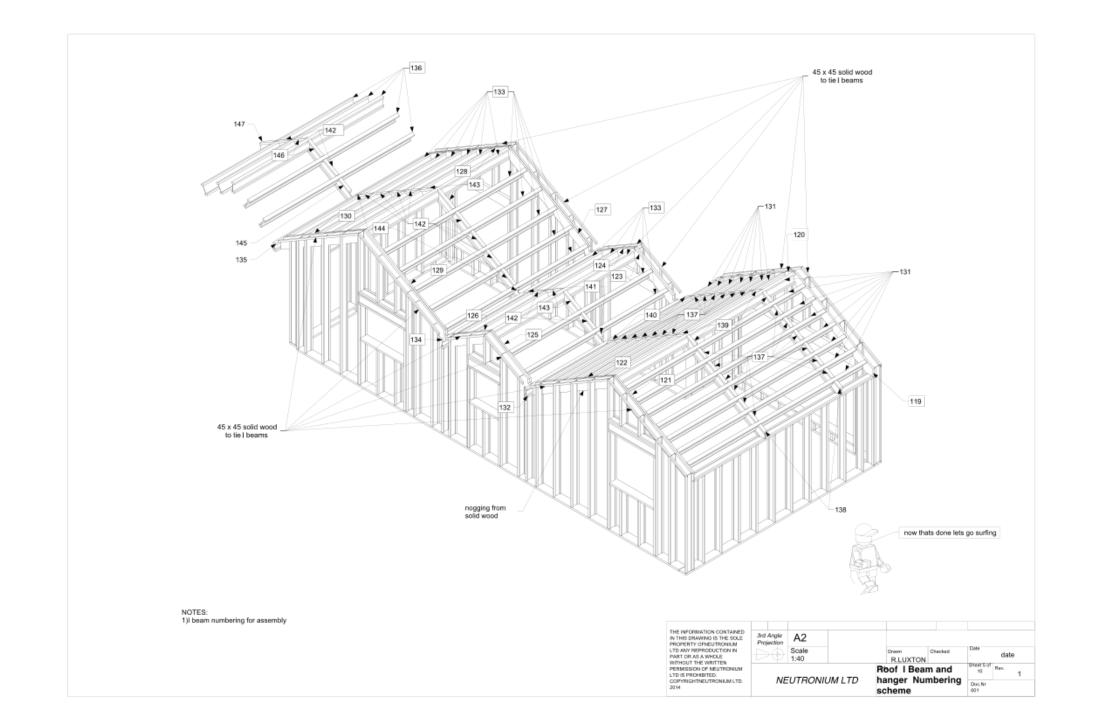

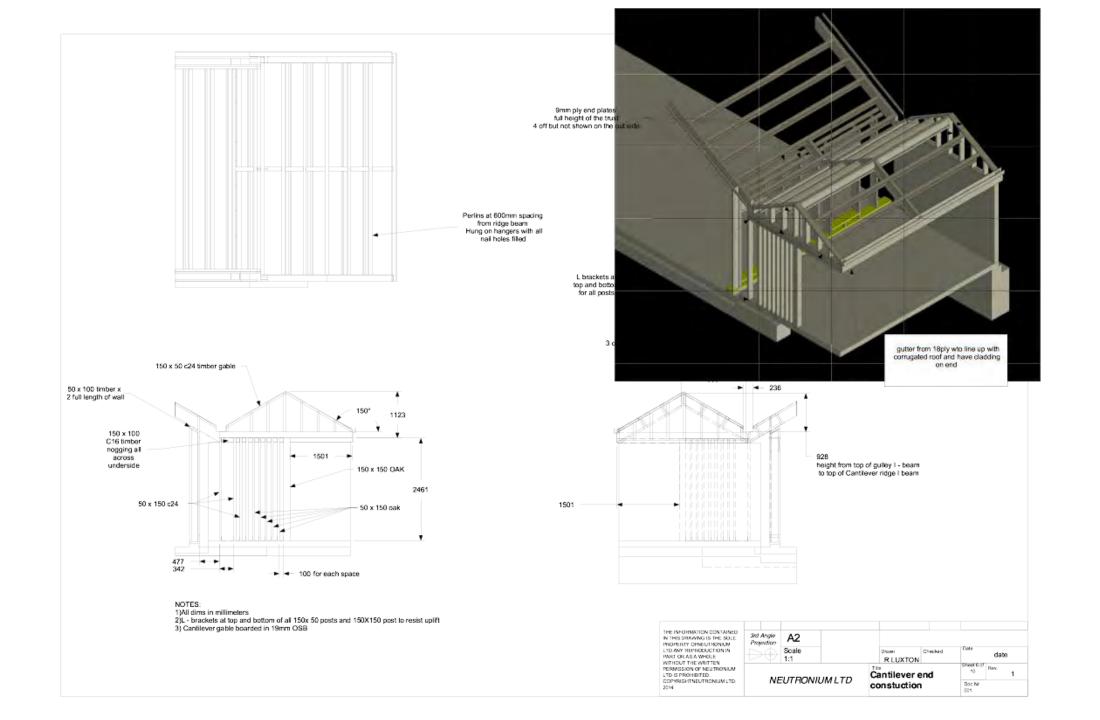


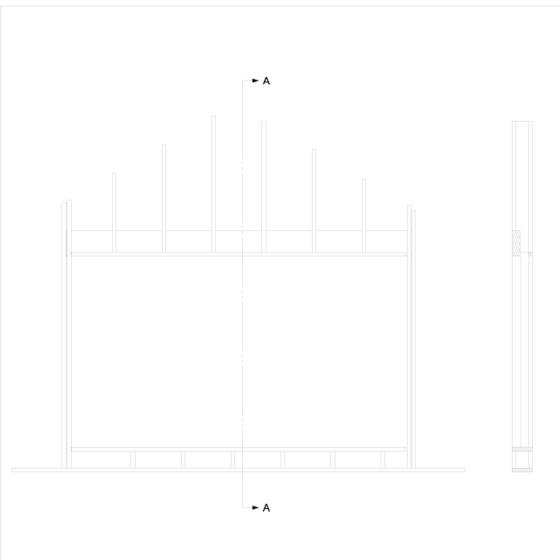

NOTES: 1)All dims in millimeters 2Untel detail for openning A, B and C 3) 47 x 72 timbers by cutting 150 x 47 timber in half

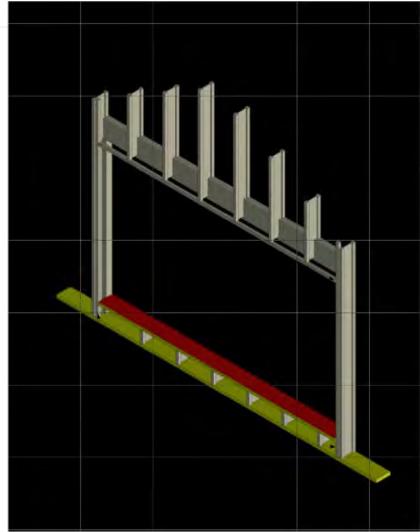

| ite | |
|------|--|
| date | |
| | |
| | |

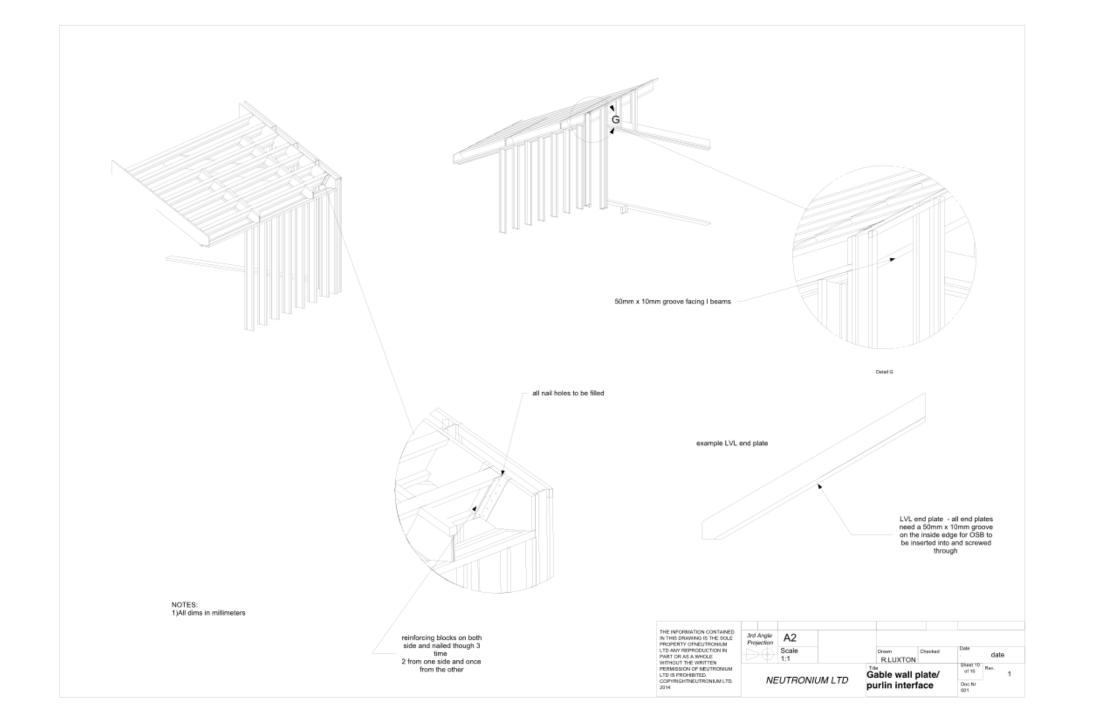






























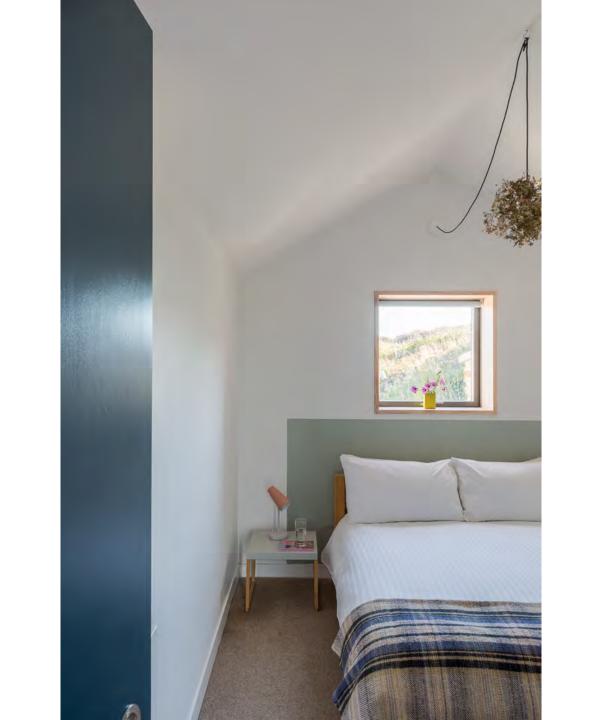



Thoughts on new build.....a place















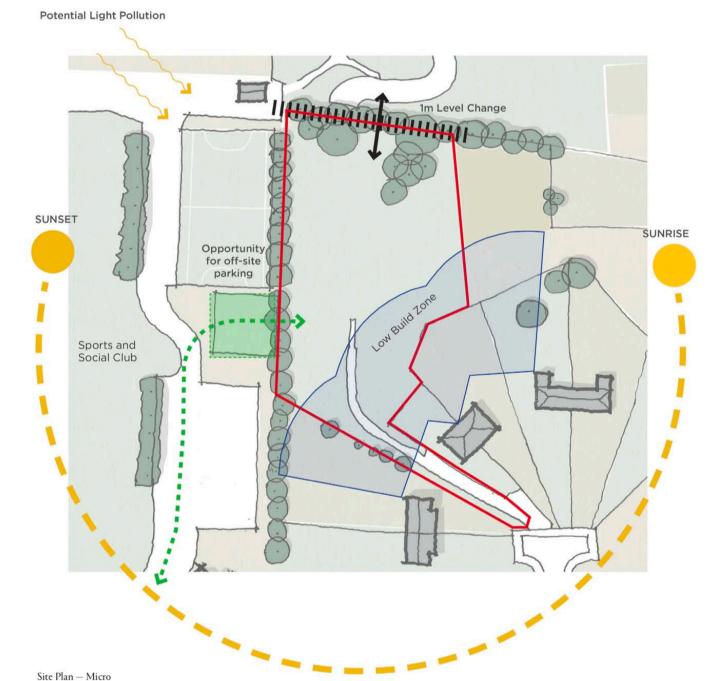

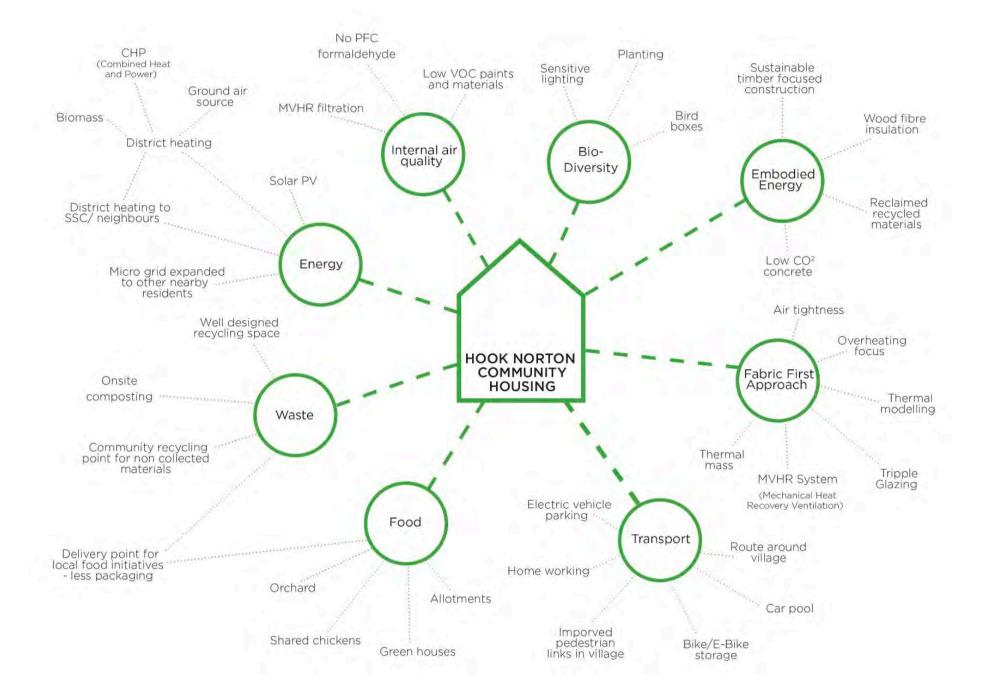

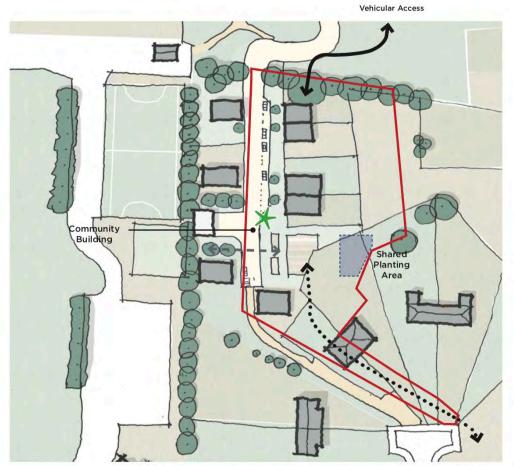

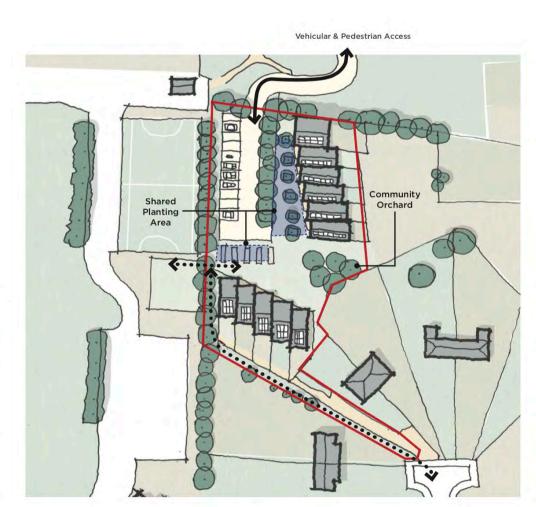

Pedestrian Access

